

DEPARTMENT OF REGULATORY AND ECONOMIC RESOURCES (RER) BOARD AND CODE ADMINISTRATION DIVISION

NOTICE OF ACCEPTANCE (NOA)

MIAMI-DADE COUNTY, FLORIDA PRODUCT CONTROL SECTION 11805 SW 26 Street, Room 208 Miami, Florida 33175-2474 T (786) 315-2590 F (786) 315-2599

www.miamidade.gov/economy

Kawneer Company, Inc. 555 Guthridge Court Norcross, GA 30092

Scope:

This NOA is being issued under the applicable rules and regulations governing the use of construction materials. The documentation submitted has been reviewed and accepted by Miami-Dade County RER-Product Control Section to be used in Miami-Dade County and other areas where allowed by the Authority Having Jurisdiction (AHJ).

This NOA shall not be valid after the expiration date stated below. The Miami-Dade County Product Control Section (In Miami-Dade County) and/ or the AHJ (in areas other than Miami-Dade County) reserve the right to have this product or material tested for quality assurance purposes. If this product or material fails to perform in the accepted manner, the manufacturer will incur the expense of such testing and the AHJ may immediately revoke, modify, or suspend the use of such product or material within their jurisdiction. RER reserves the right to revoke this acceptance, if it is determined by Miami-Dade County Product Control Section that this product or material fails to meet the requirements of the applicable building code. This product is approved as described herein, and has been designed to comply with the Florida Building Code, including the High Velocity Hurricane Zone.

DESCRIPTION:

Series "AA900 ISOWEB" Thermal Broken Outswing Aluminum Casement Window - L.M.I.

APPROVAL DOCUMENT: Drawing No. 1545, Series titled "AA900 ISOWEB Out-Swing L.M.I. Casement Window", sheets 01 through 06 of 06, dated 07/09/07 with revision "B1", dated 06/27/12, prepared by W. W. Schaefer Engineering & Consulting, P. A., signed and sealed by Warren W. Schaefer, P. E., bearing the Miami-Dade County Product Control Section Revision Stamp with the Notice of Acceptance number and Expiration Date by the Miami-Dade County Product Control Section.

MISSILE IMPACT RATING: Large and Small Missile Impact Resistant

LABELING: Each unit shall bear a permanent label with the manufacturer's name or logo, city, state, series, and following statement: "Miami-Dade County Product Control Approved", unless otherwise noted herein.

RENEWAL of this NOA shall be considered after a renewal application has been filed and there has been no change in the applicable building code negatively affecting the performance of this product.

TERMINATION of this NOA will occur after the expiration date or if there has been a revision or change in the materials, use, and/ or manufacture of the product or process. Misuse of this NOA as an endorsement of any product, for sales, advertising or any other purposes shall automatically terminate this NOA. Failure to comply with any section of this NOA shall be cause for termination and removal of NOA.

ADVERTISEMENT: The NOA number preceded by the words Miami-Dade County, Florida, and followed by the expiration date may be displayed in advertising literature. If any portion of the NOA is displayed, then it shall be done in its entirety.

INSPECTION: A copy of this entire NOA shall be provided to the user by the manufacturer or its distributors and shall be available for inspection at the job site at the request of the Building Official.

This NOA revises NOA No. 12-0813.04 and consists of this page 1 and evidence pages E-1, E-2 and E-3, as well as approval document mentioned above.

The submitted documentation was reviewed by Jaime D. Gascon, P. E.



J.GASCON

NOA No. 14-0430.10 Expiration Date: December 27, 2017 Approval Date: August 14, 2014

Page 1

Kawneer Company, Inc.

NOTICE OF ACCEPTANCE: EVIDENCE SUBMITTED

A. DRAWINGS

- 1. Manufacturer's die drawings and sections. (Submitted under previous NOA No. 07–0810.03)
- 2. Drawing No. 1545, Series titled "AA900 ISOWEB Out-Swing L.M.I. Casement Window", sheets 01 through 06 of 06, dated 07/09/07 with revision "B1", dated 06/27/12, prepared by W. W. Schaefer Engineering & Consulting, P. A., signed and sealed by Warren W. Schaefer, P. E.

(Submitted under previous NOA No. 12-0813.04)

B. TESTS

- 1. Test reports on: 1) Air Infiltration Test, per FBC, TAS 202–94
 - 2) Uniform Static Air Pressure Test, Loading per FBC TAS 202–94
 - 3) Water Resistance Test, per FBC, TAS 202-94
 - 4) Small Missile Impact Test per FBC, TAS 201-94
 - 5) Large Missile Impact Test per FBC, TAS 201-94
 - 6) Cyclic Wind Pressure Loading per FBC, TAS 203-94
 - 7) Forced Entry Test, per FBC 2411.3.2.1, TAS 202-94

along with marked-up drawings and installation diagram of an outswing Aluminum casement window, prepared by Hurricane Testing Laboratory, LLC, Test Report No. HTL-G049-0301-07, dated 06/06/07, signed and sealed by Vinu J. Abraham, P. E. (Submitted under previous NOA No. 07-0810.03)

C. CALCULATIONS

- 1. Anchor verification calculations and structural analysis, complying with FBC, prepared by W. W. Schaefer Engineering & Consulting, P.A., dated 01/05/12, signed and sealed by Warren W. Schaefer, P. E. (Submitted under previous NOA No. 11–1027.07)
- 2. Glazing complies with ASTM E1300-98/09

D. QUALITY ASSURANCE

1. Miami-Dade Department of Regulatory and Economic Resources (RER).

E. MATERIAL CERTIFICATIONS

- 1. Notice of Acceptance No. 11-0624.02 issued to E.I. DuPont DeNemours & Co., Inc. for their "DuPont SentryGlas® Interlayer" dated 08/25/11, expiring on 01/14/17.
- 2. Notice of Acceptance No. 13-0129.27 issued to E.I. DuPont DeNemours & Co., Inc. for their "DuPont Butacite® PVB Interlayer" dated 04/11/13, expiring on 12/11/16.

Jaime D. Gascon, P. E. Product Control Section Supervisor

NOA No. 14-0430.10

Expiration Date: December 27, 2017 Approval Date: August 14, 2014

NOTICE OF ACCEPTANCE: EVIDENCE SUBMITTED

E. MATERIAL CERTIFICATIONS (CONTINUED)

- 3. Notice of Acceptance No. 12–1231.10 issued to Eastman Chemical Company (MA) for their "Saflex Clear and Color Glass Interlayers" dated 03/28/13, expiring on 05/21/16.
- 4. Notice of Acceptance No. 12–1231.08 issued to Eastman Chemical Company (MA) for their "Saflex CP Saflex and Saflex HP Composite Glass Interlayers with PET Core" dated 03/28/13, expiring on 12/11/18.
- 5. Notice of Acceptance No. 12–1231.09 issued to Eastman Chemical Company (MA) for their "Saflex HP Clear or Color Glass Interlayers" dated 03/28/13, expiring on 04/14/18.
- 6. Test Report on 1) ASTM G155-00ae1 "Standard Practice for Operating Xenon Arc Apparatus for Exposure of Non-Metallic Materials" accelerated weathering,
 - 2) ASTM D638-03 "Standard Test Methods for Tensile Properties of Plastics",
 - 3) ASTM D635–98 "Standard Test Method for Rate of Burning and/or Extent and Time of Burning of Self–Supporting Plastics in a Horizontal Position",
 - 4) ASTM D2843-99 "Standard Test Method for Density of Smoke from the Burning or Decomposition of Plastics" and
 - 5) **ASTM D1929–96** "Standard Test Method for Ignition Properties of Plastics"

along with marked-up drawings and installation diagram of an "Insulbar Tecatherm 66 GF" (Thermal Barrier), issued to Ensinger, Inc., prepared by Architectural Testing, Inc., Test Report No. **ATI-06520.02-106-18**, dated 12/01/06, signed and sealed by Joseph A. Reed, P. E.

(Submitted under previous NOA No. 07-0810.03)

F. STATEMENTS

- 1. Statement letter of conformance to and compliance with the FBC 5th Edition (2014), prepared by W. W. Schaefer Engineering & Consulting, P.A., dated 04/14/14 signed and sealed by Warren W. Schaefer, P. E.
- 2. Statement letter of the exterior sealant change from "DOW Corning InstantGlaze" to "Novaguard SBC40–M170", dated 06/26/12, signed by Warren W. Schaefer, P. E. (Submitted under previous NOA No. 12–0813.04)
- 3. Statement letter of conformance and compliance with the FBC-2010 and ANSI/AAMA/NWWDA 101/ I.S. 2-97, dated 10/10/11 signed and sealed by Warren W. Schaefer, P. E.

(Submitted under previous NOA No. 11-1027.07)

Jaime D. Gascon, P. E.

Product Control Section Supervisor

NOA No. 14-0430.10

Expiration Date: December 27, 2017 Approval Date: August 14, 2014

Kawneer Company, Inc.

NOTICE OF ACCEPTANCE: EVIDENCE SUBMITTED

F. STATEMENTS (CONTINUED)

- 4. Statement letter of no financial interest and independence, dated 10/10/11, signed and sealed by Warren W. Schaefer, P. E.
 - (Submitted under previous NOA No. 11–1027.07)
- 5. Proposal No. 11–0976 issued by Product Control for the change of, or for the addition of the "GE Momentive RGS 7700" exterior sealant, dated 08/30/2011, signed by Manuel Perez, P. E.

(Submitted under previous NOA No. 11-1027.07)

- 6. Statement letter of conformance, no financial interest, conformance to and compliance with the ANSI/ AAMA/ NWWDA 101/ I.S. 2–97, FBC-2004 and FBC-2007 including supplements, dated 07/31/07, prepared by W. W. Schaefer Engineering & Consulting, P.A., signed and sealed by Warren W. Schaefer, P. E. (Submitted under previous NOA No. 07-0810.03)
- 7. Laboratory compliance letter for Test Report No. ATI-06520.02-106-18, issued by Architectural Testing, Inc., dated 12/01/06, signed and sealed by Joseph A. Reed, P. E. (Submitted under previous NOA No. 07-0810.03)
- 8. Laboratory compliance letter for Test Report No. HTL-G049-0301-07, issued by Hurricane Test Laboratory, LLC, dated 06/06/07, signed and sealed by Vinu J. Abraham, P. E.

(Submitted under previous NOA No. 07-0810.03)

G. OTHERS


1. Notice of Acceptance No. 12-0813.04, issued to Kawneer Company, Inc. for their Series "AA900 ISOWEB Outswing Aluminum Casement Window – L.M.I.", approved on 10/25/12 and expiring on 12/27/17.


Jaime D. Gascon, P. E.

Product Control Section Supervisor

NOA No. 14-0430.10

Expiration Date: December 27, 2017 Approval Date: August 14, 2014

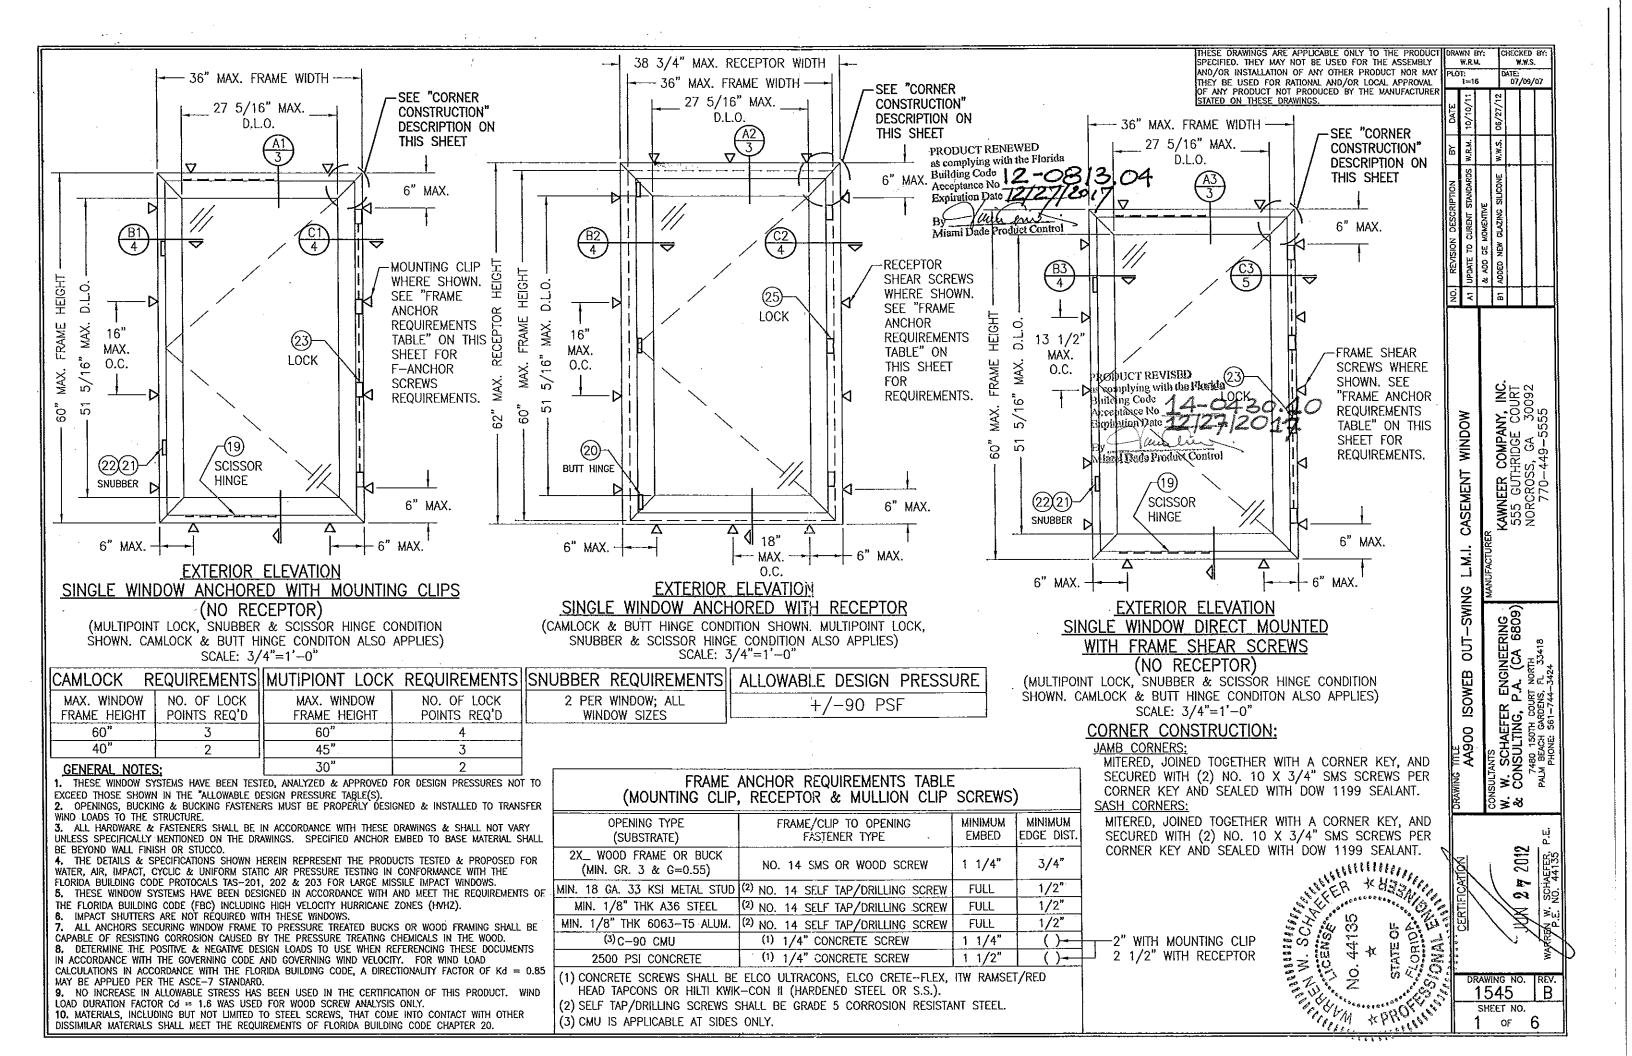

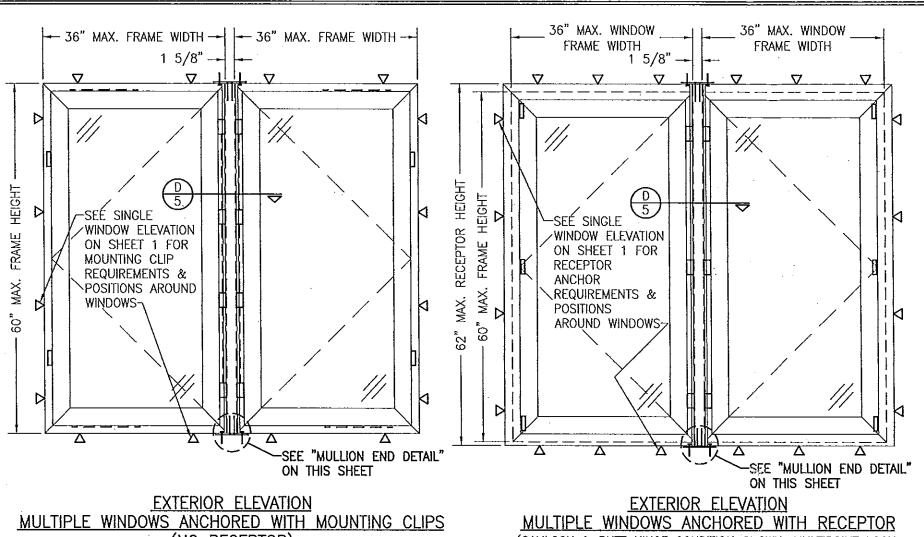


(NO RECEPTOR)

(MULTIPOINT LOCK, SNUBBER & SCISSOR HINGE CONDITION SHOWN. CAMLOCK & BUTT HINGE CONDITON ALSO APPLIES) SCALE: 3/4"=1'-0"

(CAMLOCK & BUTT HINGE CONDITION SHOWN. MULTIPOINT LOCK, SNUBBER & SCISSOR HINGE CONDITION ALSO APPLIES)

SCALE: 3/4"=1'-0"

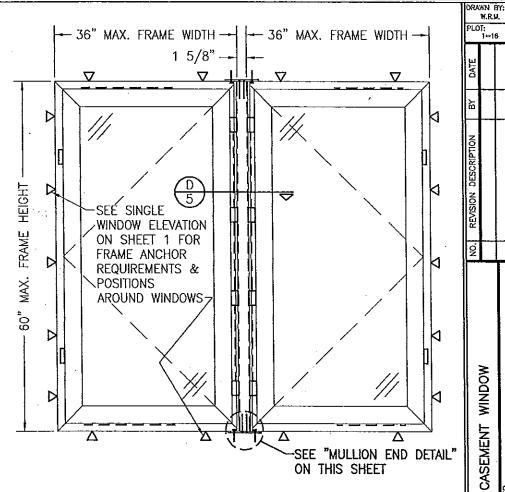

EXTERIOR ELEVATION MULTIPLE WINDOW DIRECT MOUNTED WITH FRAME SHEAR SCREWS (NO RECEPTOR)

(MULTIPOINT LOCK, SNUBBER & SCISSOR HINGE CONDITION SHOWN. CAMLOCK & BUTT HINGE CONDITON ALSO APPLIES) SCALE: 3/4"=1'-0"

ANCHORS PER "FRAME ANCHOR REQUIREMENTS TABLE" ON SHEET 1 (2 PER CLIP) SUBSTRATE BY OTHERS PER FRAME ANCHOR REQUIREMENTS MULLION END DETAIL TABLE

(WINDOW FRAMES NOT SHOWN FOR CLARITY)

SCALE: N.T.S.

MULTIPLE UNIT NOTES:

1. FOR ALL DETAIL NOT SHOWN, SEE SINGLE WINDOW ELEVATION. 2. THERE IS NO LIMIT ON THE NUMBER OF WINDOWS THAT MAY BE COMBINED HORIZONTALLY INTO ONE OPENING PROVIDING THE OPENING IS DESIGNED TO SUPPORT ALL LOADS TRANSFERED FROM THE WINDOWS & THEIR MULLIONS.

3. LOCK SIDE OF WINDOWS MAY BE AT MULLION SIDE OR OPENING SIDE.

> PRODUCT REVISED as complying with the Florida Acceptance No ' Expiration Date 1 acces Miami Dade Product Contro PRODUCT RENEWED as complying with the Florida Building Code -0813.04 Acceptance No

COENS NO NO TO TO SERVICE STATE OF THE PARTY OF TH

OMAL

В 1545 SHEET NO. 2 OF

CHECKED BY: W.W.S.

XATE: 07/09/07

KAWNEER COMPANY, INC. 555 GUTHRIDGE COURT NORCROSS, GA 30092 770-449-5555

NSULTANTS

W. SCHAEFER ENGINEERING
CONSULTING, P.A. (CA 6809)
7480 150TH COURT NORTH
PALM BEACH GARDENS, FL. 33418
PHONE: 561-744-3424

WINDOW


CASEMENT


L.M.I.


OUT-SWING


SOWEB

Miami Dade Product Control

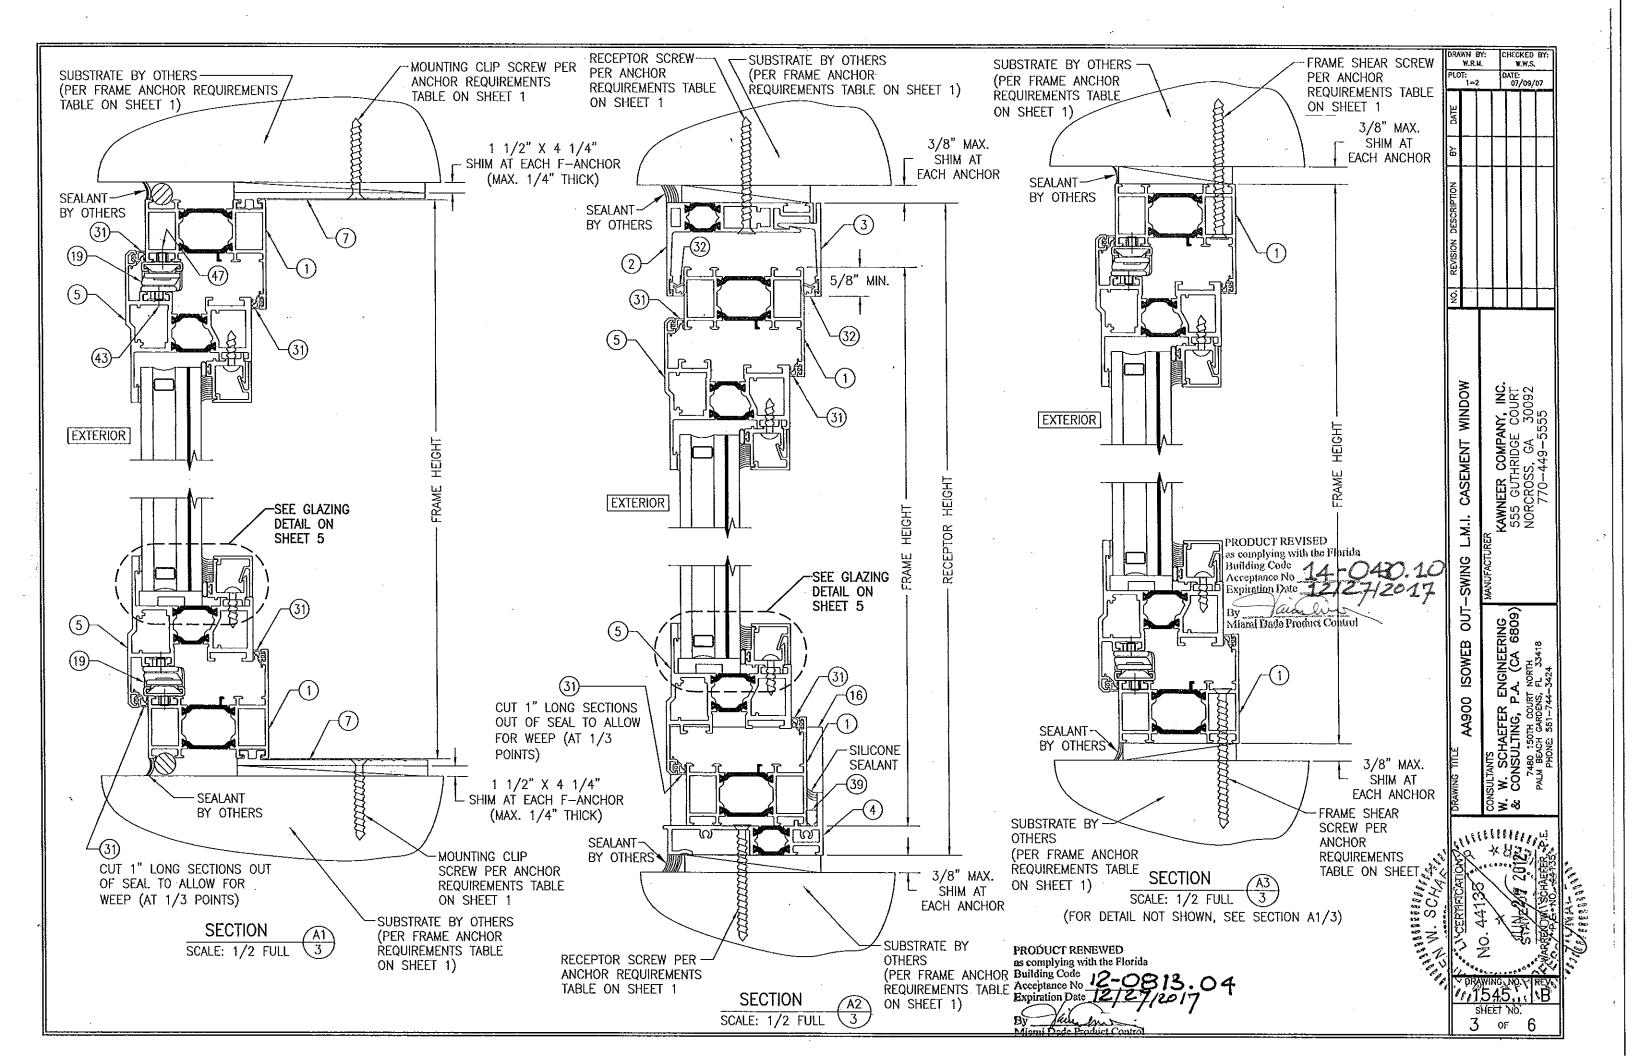


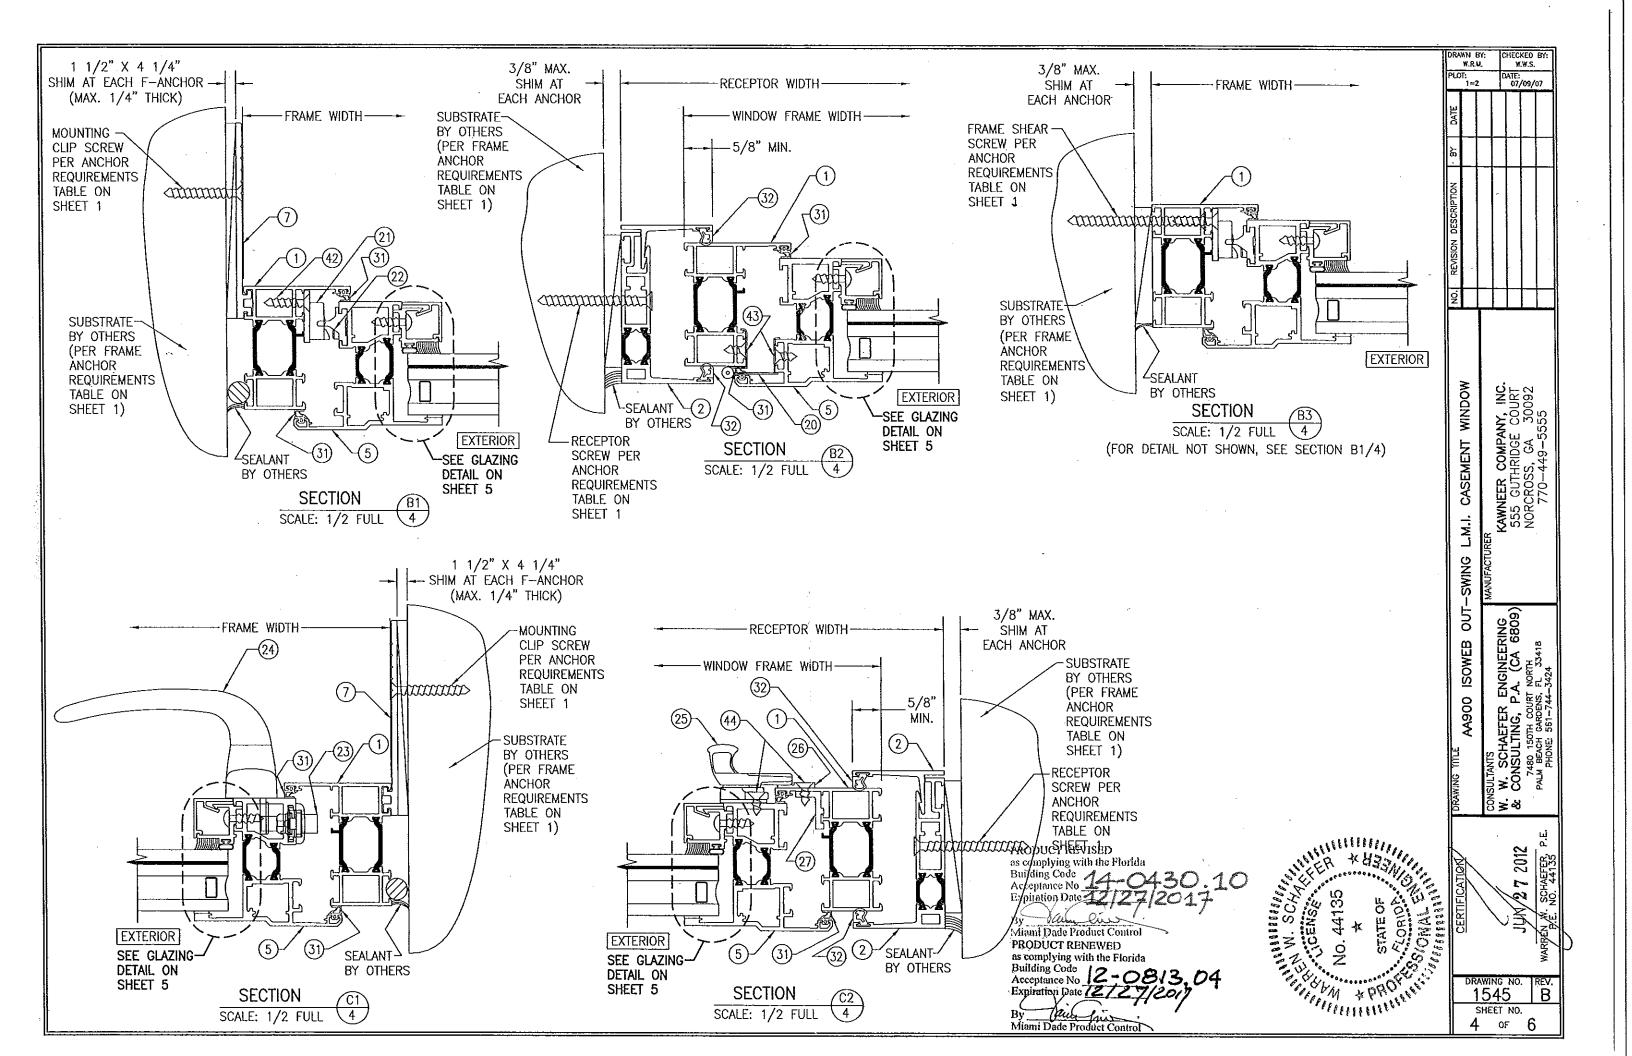

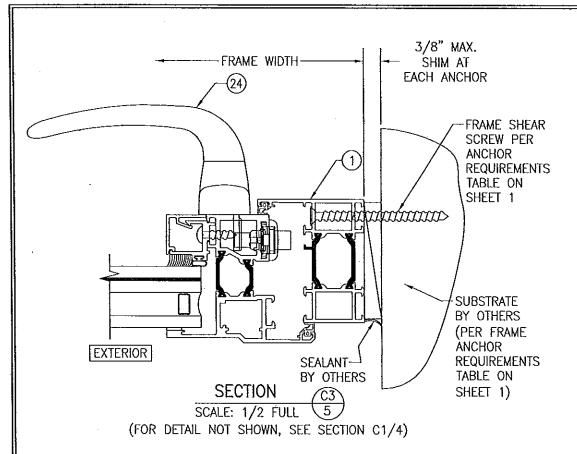

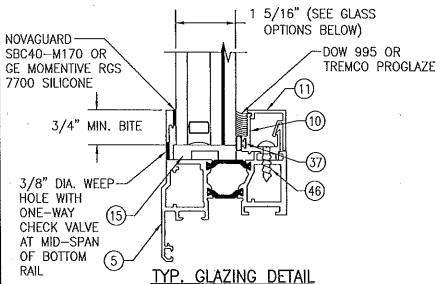


GLASS OPTION 1: 1 5/16" LAMINATED I.G. (1/4" HT.ST./0.075" SOLUTIA VANCEVA/1/4" HT.ST. INTERIOR; 1/2" AIR SPACE; 1/4" TEMP. EXTÉRIOR) GLASS OPTION 2: 1 5/16" LAMINATED I.G. (1/4" HT.ST./0.10" SOLUTIA SAFLEX HP/1/4" HT.ST. INTERIOR; 1/2" AIR SPACE; 1/4" TEMP. EXTERIOR) <u>GLASS OPTION 3:</u> 1 5/16" LAMINATED I.G. (1/4" HT.ST./0.090" DUPONT SG/1/4" HT.ST. INTERIOR; 1/2" AIR SPACE; 1/4" TEMP. EXTÉRIOR) GLASS OPTION 4: 1 5/16" LAMINATED I.G. (1/4" HT.ST./0.090" SOLUTIA SALFEX IIIG PVB/1/4" HT.ST. INTERIOR; 1/2" AIR SPACE; 1/4" TEMP. EXTERIOR) GLASS OPTION 5: 1 5/16" LAMINATED I.G. (1/4" HT.ST./0.090" DUPONT BUTICITE PVB/1/4" HT.ST. INTERIOR; 1/2" AIR SPACE; 1/4" TEMP. EXTERIOR)

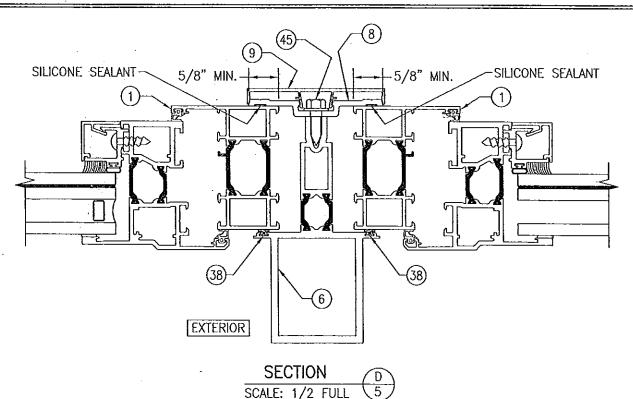

(FOR HARDARE CONDITIONS & DETAILS NOT SHOWN; SEE OTHER SECTIONS)

> PRODUCT REVISED as complying with the Florida Acceptance No Expiration Date Aiami Dade Product Control PRODUCT RENEWED as complying with the Florida Building Code 12-0813.04

Miami Dade Product Control

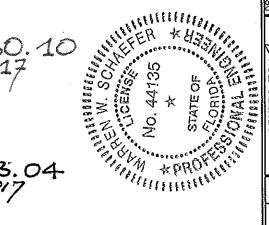

2012

R ENGINEERING
P.A. (CA 6809)

NURT NORTH

TANANA PA 33418

DRAWN BY: W.R.M.

1=2

WINDOW

CASEMENT

E.

OUT-SWING

ISOWEB

JATE: 07/03/07

1545 SHEET NO.

5 of

